1. ALL CONTRACTORS ARE REQUIRED TO VISIT THE SITE AND BE KNOWLEDGEABLE REGARDING EXISTING CONDITIONS

AND THEIR EFFECT ON THE PROPOSED WORK. CONTRACTORS SHALL VERIFY AND BE RESPONSIBLE FOR, ANY

2. NOTIFY THE OWNER'S REPRESENTATIVE A MINIMUM OF 72 HOURS PRIOR TO THE INTERRUPTION OF ANY UTILITY.

3. CONTRACTORS AND SUBCONTRACTORS SHALL COORDINATE THEIR WORK WITH THAT OF OTHER TRADES.

4. NO WORK WILL BE PERMITTED TO BE INSTALLED WITHOUT RECEIPT AND SUBSEQUENT REVIEW OF FULL AND

6. VERIFY ALL DIMENSIONS AND ELEVATIONS IN THE FIELD. WHERE DISCREPANCIES ARE FOUND BETWEEN DIMENSIONS

7.1. <u>FURNISH:</u> SUPPLY, DELIVER TO AND UNLOAD AT PROJECT SITE READY FOR ASSEMBLY AND INCORPORATION

7.2. <u>INSTALL:</u> AT THE PROJECT SITE, UNPACK/UNCRATE ASSEMBLE, PLACE, ANCHOR, FINISH, PROTECT, CLEAN,

INTO THE WORK. LEGALLY DISPOSE OF OR RECYCLE PACKAGING AND EXTRA MATERIAL OFF-SITE.

8. WHERE CONFLICTS MAY EXIST BETWEEN THE REQUIREMENTS OF PORTIONS OF THE CONTRACT DOCUMENTS, THE

GREATER QUANTITY, HIGHER QUALITY OR MORE STRINGENT REQUIREMENT SHALL GOVERN. THEREFORE, BY

ISSUED DURING THE BIDDING PROCESS, IT HAS VOLUNTEERED TO COMPLY WITH THE MORE EXPENSIVE

EXECUTING A CONTRACT FOR CONSTRUCTION, THE CONTRACTOR AGREES THAT, IF IT RAISED NO QUESTIONS

REGARDING SUCH CONFLICTS DURING THE BIDDING PROCESS. AND IN THE ABSENCE OF A CLARIFYING ADDENDUM

REQUIREMENT AS PART OF ITS BASE BID AND IS NOT ENTITLED TO ANY ADDITIONAL COMPENSATION TO RESOLVE

SET FORTH THE DESIGN INTENT AND. THEREFORE, MAY NOT EXPRESSLY DEPICT EVERY LENGTH, SEGMENT, PIECE,

PART, COMPONENT OR UNIT OF A PRODUCT, SYSTEM OR SERVICE. THE CONTRACTOR FURTHER AGREES THAT, AS

PART OF ITS BID, IT MUST FURNISH AND INSTALL EVERY LENGTH, SEGMENT, PIECE, PART, COMPONENT OR UNIT

OF A PRODUCT, SYSTEM OR SERVICE AND, CONSEQUENTLY, THE CONTRACTOR IS NOT ENTITLED TO ANY

10. ARCHITECT SHALL BE NAMED AS ADDITIONAL INSURED ON ALL REQUIRED INSURANCE POLICIES.

ADDITIONAL COMPENSATION FOR ANY LENGTH, SEGMENT, PIECE, PART COMPONENT OR UNIT OF A PRODUCT,

9. THE CONTRACT DOCUMENTS REQUIRE THE CONTRACTOR TO FURNISH AND INSTALL COMPLETE PRODUCTS, SYSTEMS AND SERVICES. BY EXECUTING A CONTRACT FOR CONSTRUCTION, THE CONTRACTOR AGREES THAT THE DRAWINGS

7.3. PROJECT SITE: THE SPACE AVAILABLE TO THE CONTRACTOR FOR PERFORMANCE OF CONSTRUCTION

AND PERFORM ALL OTHER SIMILAR OPERATIONS REQUIRED TO FULLY AND PROPERLY INCORPORATE AN ITEM

ACTIVITIES. THE EXTENT OF THE PROJECT SITE IS THE AREAS TO BE REMODELED AS INDICATED ON THE

DRAWINGS, AND EXTENDS TO SUCH AREAS AS CONTAIN TERMINATIONS FOR POWER, DATA AND OTHER

CONDITIONS REQUIRING MODIFICATION BEFORE PROCEEDING WITH THE PROJECT.

5. DO NOT SCALE DRAWINGS, DIMENSIONS INDICATED TAKE PRECEDENCE OVER SCALE.

7.4. OFF-SITE: OUTSIDE THE PROPERTY IN WHICH THE PROJECT SITE IS LOCATED.

SYSTEM OR SERVICE BECAUSE IT IS NOT EXPRESSLY DEPICTED HEREIN.

ACOUSTIC TILE CEILING (TYPE)

ATANCHOR BOLT

- ABOVE FINISH FLOOR

ABOVE FINISH GRADE

ABRASIVE

ACOUSTIC

ADDITION

ADDITIONAL

ADJACENT

ADJUSTABLE

ALUMINUM

ALTERNATE

- ACCESS PANE

APPROXIMATE

ANCHOR

ASPHALT

AVERAGE

BASEMENT

BUILDING

BEAM

BITUMINOUS/BITUMASTIC

- CONSTRUCTION/CONTRACTION JOINT

CEMENT PLASTER (TYPE)

CERAMIC PAVER TILE (TYPE)

CAST— IN— PLACE CONCRETE

- CONCRETE MASONRY UNIT

BLOCKING (WOOD)

BENT STEEL PLATE

BENCH MARK

BEARING

BRACKE BRICK

BOTTOM

CABINET

CEILING

COLUMN

CLEAN OUT

COMBINATION

COMPRESSIBL

COMPACTED

CONCRETE

CONDITION

- COUNTER

- CENTER(S)

DIAMETER

DIMENSION

DRAWINGS

ELEVATION

ELEVATOR

EMBEDMENT

EMERGENCY

EPOXY PAINT

EACH WAY

EXISTING

EQUAL

EXPANSION JOINT

ELECTRIC/ELECTRICAL

ELECTRICAL CONTRACTOR

ELECTRIC WATER COOLER

ELECTRIC WATER HEATER

EXHIBIT RAIL (LENGTH)

DOWN

- DOOR

DOWELS

EACH

CONTINUOUS

CONTRACT (OR

– CARPET (TYPE)

COUNTER SINK

CONCRETE OPENING

CERAMIC TILE (TYPE)

CABINET ÚNIT HEATER

CABINET UNIT VENTILATOR

CLEAR

BSMT

BLK'G

BTW'N

COMB COMP

CONC

CPT-(1

CTR SK

DWG'S

DWL'S

ELEC CONTR

EMBED

EMER

CTR `

COMPT'D

CONC OPNG

CEM PL-(1) CT PAV-(1)

BT STL PL

AUTOMATIC

7.5. PROVIDE: FURNISH AND INSTALL, AS DEFINED ABOVE.

OR ELEVATIONS SHOWN AND ACTUAL FIELD CONDITIONS, NOTIFY ARCHITECT/ENGINEER.

COMPLETE SUBMITTALS BY THE ARCHITECT/ENGINEER.

7. DEFINITIONS:

THE CONFLICT.

- 1.2. SALVAGE: CAREFULLY, SO AS TO PRESERVE INTEGRITY AND USEFULNESS, DISCONNECT FROM SERVICES, UNFASTEN, REMOVE, DISASSEMBLE IF NECESSARY, AND STORE TEMPORARILY FOR REINCORPORATION INTO THE WORK OR FOR DELIVERY/TURN-OVER TO THE OWNER AS INDICATED IN
- 1.3. SALVAGE IN PLACE: PROTECT, RE-USE, CLEAN, RE-CONDITION IF NECESSARTY, REFINISH IF INDICATED IN THE DRAWINGS, EXISTING INSTALLED ITEM/COMPONENT WITHOUT DISCONNECTING, UNFASTENING OR REMOVING FROM THE WORK.
- 2. BRING ANY UNFORESEEN OR CONFLICTING CONDITIONS TO THE IMMEDIATE ATTENTION OF THE ARCHITECT/ENGINEER BEFORE PROCEEDING WITH THE WORK.
- REPAIR, PATCH, OR REPLACE FINISH MATERIALS OR VISIBLE ASSEMBLIES THAT ARE SOILED, CUT OR DAMAGED IN ANY FASHION DURING THE COURSE OF THE WORK, PERFORM PATCHING SUCH THAT EDGES BLEND INTO CONTIGUOUS SURFACES SMOOTHLY, MATCHING TEXTURE AND COLOR OF ADJACENT
- 4. SEAL PENETRATIONS OF DUCTWORK, CONDUIT OR PIPES WITH UL APPROVED MATERIALS TO MAINTAIN THE FIRE RATING OF ASSEMBLIES.
- APPLY APPROPRIATE & COMPATIBLE SEALANT MATERIALS AS REQUIRED TO SEPARATE DISSIMILAR METALS. FILL GAPS IN EXISTING ASSEMBLIES OR WHERE NEW AND EXISTING ASSEMBLIES MEET OR WHERE OTHERWISE REQUIRED BY THE SPECIFICATIONS.
- 6. UNTIL PERMANENT LIGHTING IS IN PLACE AND ENERGIZED, PROVIDE AND MAINTAIN TEMPORARY LIGHTING IN THE PROJECT AREAS. TO ACHIEVE A MINIMUM LIGHTING LEVEL OF 2 WATTS PER S.F.
- OWNER WILL CONTINUE TO OCCUPY AREAS ADJACENT TO THE PROJECT AREAS DURING THE CONSTRUCTION PERIOD. COORDINATE WITH OWNER TO MINIMIZE CONFLICT AND TO FACILITATE OWNER'S OPERATIONS. LIMIT CONDUCT OF ESPECIALLY NOISY OR DISRUPTIVE WORK TO ONLY THOSE TIMES MUTUALLY AGREED TO BY OWNER. REQUEST MUTUALLY AGREEABLE TIME FROM OWNER PRIOR TO CONDUCTING SUCH WORK, AND PROCEED WITH SUCH WORK ONLY AFTER RECEIVING OWNER'S EXPRESS PERMISSION TO DO SO.
- C: BIDDING NOTES

STANDARD ABBREVIATIONS

- FLOOR DRAIN

FOUNDATION

FLOOR

GAUGE

GALVANIZED

- HEAVY DUTY

HARD WOOD (TYPE)

HARDENER

HARDWARE

HIGH POINT HORIZONTAL

HOLLOW META

- INSIDE DIAMETER

INSULATION OR INSULATING

– INCLUDE (D)

- KNOCK DOWN

LAMINATED

LAVATORY

- LEFT HAND

LOW POINT

LIGHTWEIGHT

LOUVER

MASONRY

MATERIAL

MAXIMUM

MINIMUM

MOUNT(ED)

NUMBER

OVERALL

OPENING

OPPOSITE

PARTITION

PAVEMENT

PIECE

ON CENTER

NIC

OD

OPN'G

PAV'T

MECHANICAL

MANUFACTURER

MISCELLANEOUS

NOT IN CONTRACT

OUTSIDE DIAMETER

OUTSIDE FACE

OPPOSITE HAND

PRESSURE TREATED

PERMANENT FLOOR MAT

- POUNDS PER SQUARE FOOT

- POUNDS PER SQUARE INCH

NOT TO SCALE

LONG LEG HORIZONTAL

LONG LEG VERTICAL

MASONRY OPENING

METAL THRESHOLD

MARKERBOARD— (LENGTH)

MECHANICAL CONTRACTOR

MOP SERVICE BASIN (SINK)

HEIGHT

INCH

JOINT

LONG

HARD

FRT

FUR CHN'L

FIRE EXTINGUISHER

FIRE HOSE CABINET

FURRING CHANNEL

GENERAL CONTRACTOR

GENERAL CONTRACTOR

– GYPSUM PLASTER (TYPÈ)

EXPANSIONEXPOSED CONSTRUCTION

- FIRE EXTINGUISHER CABINET

FIRE RETARDANT TREATED (RATED)

– GYPSUM WALL BOARD (DRYWALL)(TYPE)

- HEATING/VENTILATING/AIR CONDITIONING

- GENERAL CONTRACTOR TO PROVIDE A \$5,000 ALLOWANCE IN HIS/HER BID FOR UNFORSEEN/MISCELLANEOUS CONDITIONS. WHEN FIGURING THIS ALLOWANCE IN THE BID, CONTRACTOR IS TO INCLUDE ALL NECESSARY OVERHEAD AND PROFIT. THIS ALLOWANCE IS NOT FOR THE CONTRACTOR'S BENEFIT, AND IS ONLY AUTHORIZED TO CHARGE AGAINST THIS ALLOWANCE WHEN DIRECTED AND APPROVED BY JOLIET JUNIOR COLLEGE. THE CONTRACTOR WILL BE ALLOWED TO INVOICE FOR MATERIAL AND RAW LABOR COST ONLY.
- CONSTRUCTION SCHEDULE: CONSTRUCTION START AND SUBSTANTIAL COMPLETION IN ACCORDANCE WITH JJC FRONT-END
- 3. ALL LOUD AND DISRUPTIVE WORK IS TO BE PERFORMED BETWEEN THE HOURS OF 10:00 PM AND 6:00

PLB'G CONTR

PLYWD

PL-(1) R OR RAD

REQ'D

SEAL/HDNR

SPK'R

STN STD

SUSP

WDN

STD WGT

- PLASTIC LAMINATE

PLUMBING CONTRACTOR

POLYVINYL CHLORIDE

– GYPSUM PLASTER (TYPE)

RUBBER FLOORING (TYPE)

PLUMBING

PLYWOOD

RADIUS

RISER

ROOF DRAIN

RIGHT HAND

REFERANCE

REINFORCING

SQUARE FOOT

SQUARE INCH

STAINLESS STEEL

SEALER/HARDENER

SLAB ON GRADE

SPECIFICATION(S)

STANDARD WEIGHT

TONGUE AND GROOVE

TOP OF FOUNDATION

TACKBOARD (LENGTH)

UNLESS NOTED OTHERWISE

TOP OF MASONRY

VINYL BASE COVED

VINYL BASE STRAIGHT

WALL CORNER GUARD

WELDED WIRE FABRIC

WALL SERVICE BASIN

- VINYL COMPOSITION TILE

VENEER PLASTER (TYPE)

- STRUCTURAL OR STRUCTURE

SERVICE SINK

SCHEDULE

SECTION

SPACING

SPEAKER

STANDARD

SUSPEND(ED)

SYMMETRICAL

TOP OF BEAM

TOP OF CURB

TOP OF SLAB

TOP OF STEEL

TOP OF WALL

VERTICAL

WITHOUT

WINDOW

WEIGHT

WIDE OR WIDTH

WATER PROOF

TREAD

SHEET

REQUIRED

ROUGH OPENING

DRAWING NUMBER —	A6.05	LS
COLUMN NUMBER	26	AND I
LOCATION ELEVATION	T/1ST FLR.	MATEI
ROOM NUMBER	204	AND MATERIALS
DOOR NO. NEW DOOR NO. EXISTING	203.2 203.1X	LEGEND
NOMINAL THICKNESS — CONSTRUCTION TYPE — SPECIAL CONDITION —	M8 _b	ND
KEYNOTE IDENTIFICATION	15.211	
WINDOW TYPE IDENTIFICATION	⊗	

DETAIL NUMBER -

 $\widetilde{\mathcal{D}}$

W

0

TOILET ACCESSORY IDENTIFICATION **ELEVATION** CONCRETE BRICK MASONRY IN CONCRETE MASONRY IN PLAI (RUNNING BOND) CONCRETE MASONRY IN PLAN (STACK BOND) STONE MASONRY IN

RAKED JOINT IN CTRL./EXP. JOINT BRICK MASONRY II SECTION DETAIL CONCRETE

MASONRY IN SECTION DETAIL

STONE MASONRY II SECTION DETAIL STEEL IN SECTION DETAIL

DISCONTINUOUS WOOD BLOCKING IN SECTION CONTINUOUS WOOD BLOCKING IN

FINISHED WOOD IN SECTION DETAIL RIGID BOARD

INSULATION RIGID BOARD INSULATION (ROOFING)

GYPSUM BOARD

ACOUSTICAL

CEILING PANEL

BATT INSULATION

BITUMINOUS CONCRETE (ASPHALT) PAVING AGGREGATE

BALLAST, FILL OR BACKFILL IN

SECTION UNDISTURBED EARTH

KNOWLEDGE AND BELIEF, AND TO THE EXTENT OF MY CONTRACTUAL OBLIGATION, THEY ARE IN COMPLIANCE WITH IBC 2009 EDITION THE ENVIRONMENTAL BARRIERS ACT AND THE ILLINOIS ACCESSIBILITY

BLDG 'G' BLDG 'E'

KLUBER, INC. ILLINOIS PROFESSIONAL DESIGN FIRM LICENSE #184-001284

I HAVE PREPARED, OR CAUSED TO

BE PREPARED UNDER MY DIRECT

SUPERVISION, THE ATTACHED PLANS

AND SPECIFICATIONS AND STATE

THAT TO THE BEST OF MY



MECHANICAL ENGINEER'S

SEALS & CERTIFICATES

"G" SERIES

G100 COVER SHEET, GENERAL NOTES, SYMBOLS,

& DRAWING INDEX FIRST FLOOR PLAN - BUILDINGS B, C, D

FIRST FLOOR PLAN - BUILDINGS D, E, F FIRST FLOOR PLAN - BUILDINGS H, J, AND

INDEX OF DRAWINGS

SECOND FLOOR PLAN - BUILDINGS B, C, D

SECOND FLOOR PLAN - BUILDINGS D, E, PARTIAL FLOOR PLANS — BUILDINGS J AND

ROOF PLAN - BUILDINGS B. C. D AND S ROOF PLAN - BUILDINGS D, E, F AND G ME353 ROOF PLAN - BUILDINGS H, J AND K

CAMPUS EXHAUST FAN **PROJECT**

> REPLACEMENTS JOLIET JUNIOR COLLEGE 1215 HOUBOLT ROAD

JOLIET, IL 60431

OWNER

JOLIET JUNIOR COLLEGE 1215 HOUBOLT ROAD **JOLIET, IL 60431**

ARCHITECT/ **ENGINEER**

KLUBER ARCHITECTS + ENGINEERS 10 S. SHUMWAY AVE. **BATAVIA, ILLINOIS 60510** TEL 630-406-1213

630-406-9472 www.kluberinc.com

BLDG 'C'

BUILDING CODE DATA

2015 INTERNATIONAL BUILDING CODE 2014 ILLINOIS STATE PLUMBING CODE 2015 INTERNATIONAL MECHANICAL CODE 2015 INTERNATIONAL FUEL AND GAS CODE 2015 INTERNATIONAL ENERGY CODE

2015 INTERNATIONAL FIRE PREVENTION CODE 2018 IL ACCESSIBILITY CODE 2014 NATIONAL ELECTRIC CODE LOCAL AMENDMENTS TO THE ABOVE CODES

ELECTRICAL ENGINEER'S

SEAL SEAL

"G" SERIES

JOB NO. 18-292-1207 CHECKED APPROVED SHEET TITLE


> **GENERAL NOTES** SYMBOLS AND **DRAWING INDEX**


SHEET NUMBER

COVER SHEET,

ER-(26)EXIST

THE MATERIALS, ABBREVIATIONS, AND DRAFTING SYMBOLS LEGEND ARE EACH AN "M" SERIES "ME" SERIES ALL INCLUSIVE MASTER LIST USED BY THIS FIRM. THE INCLUSION OF THESE LEGENDS INTO THESE DOCUMENTS DOES NOT IMPLY THAT ALL THE SYMBOLS OR MATERIALS INCLUDED IN THESE LEGENDS ARE INCORPORATED INTO THIS PROJECT. EARTH BACKFILL

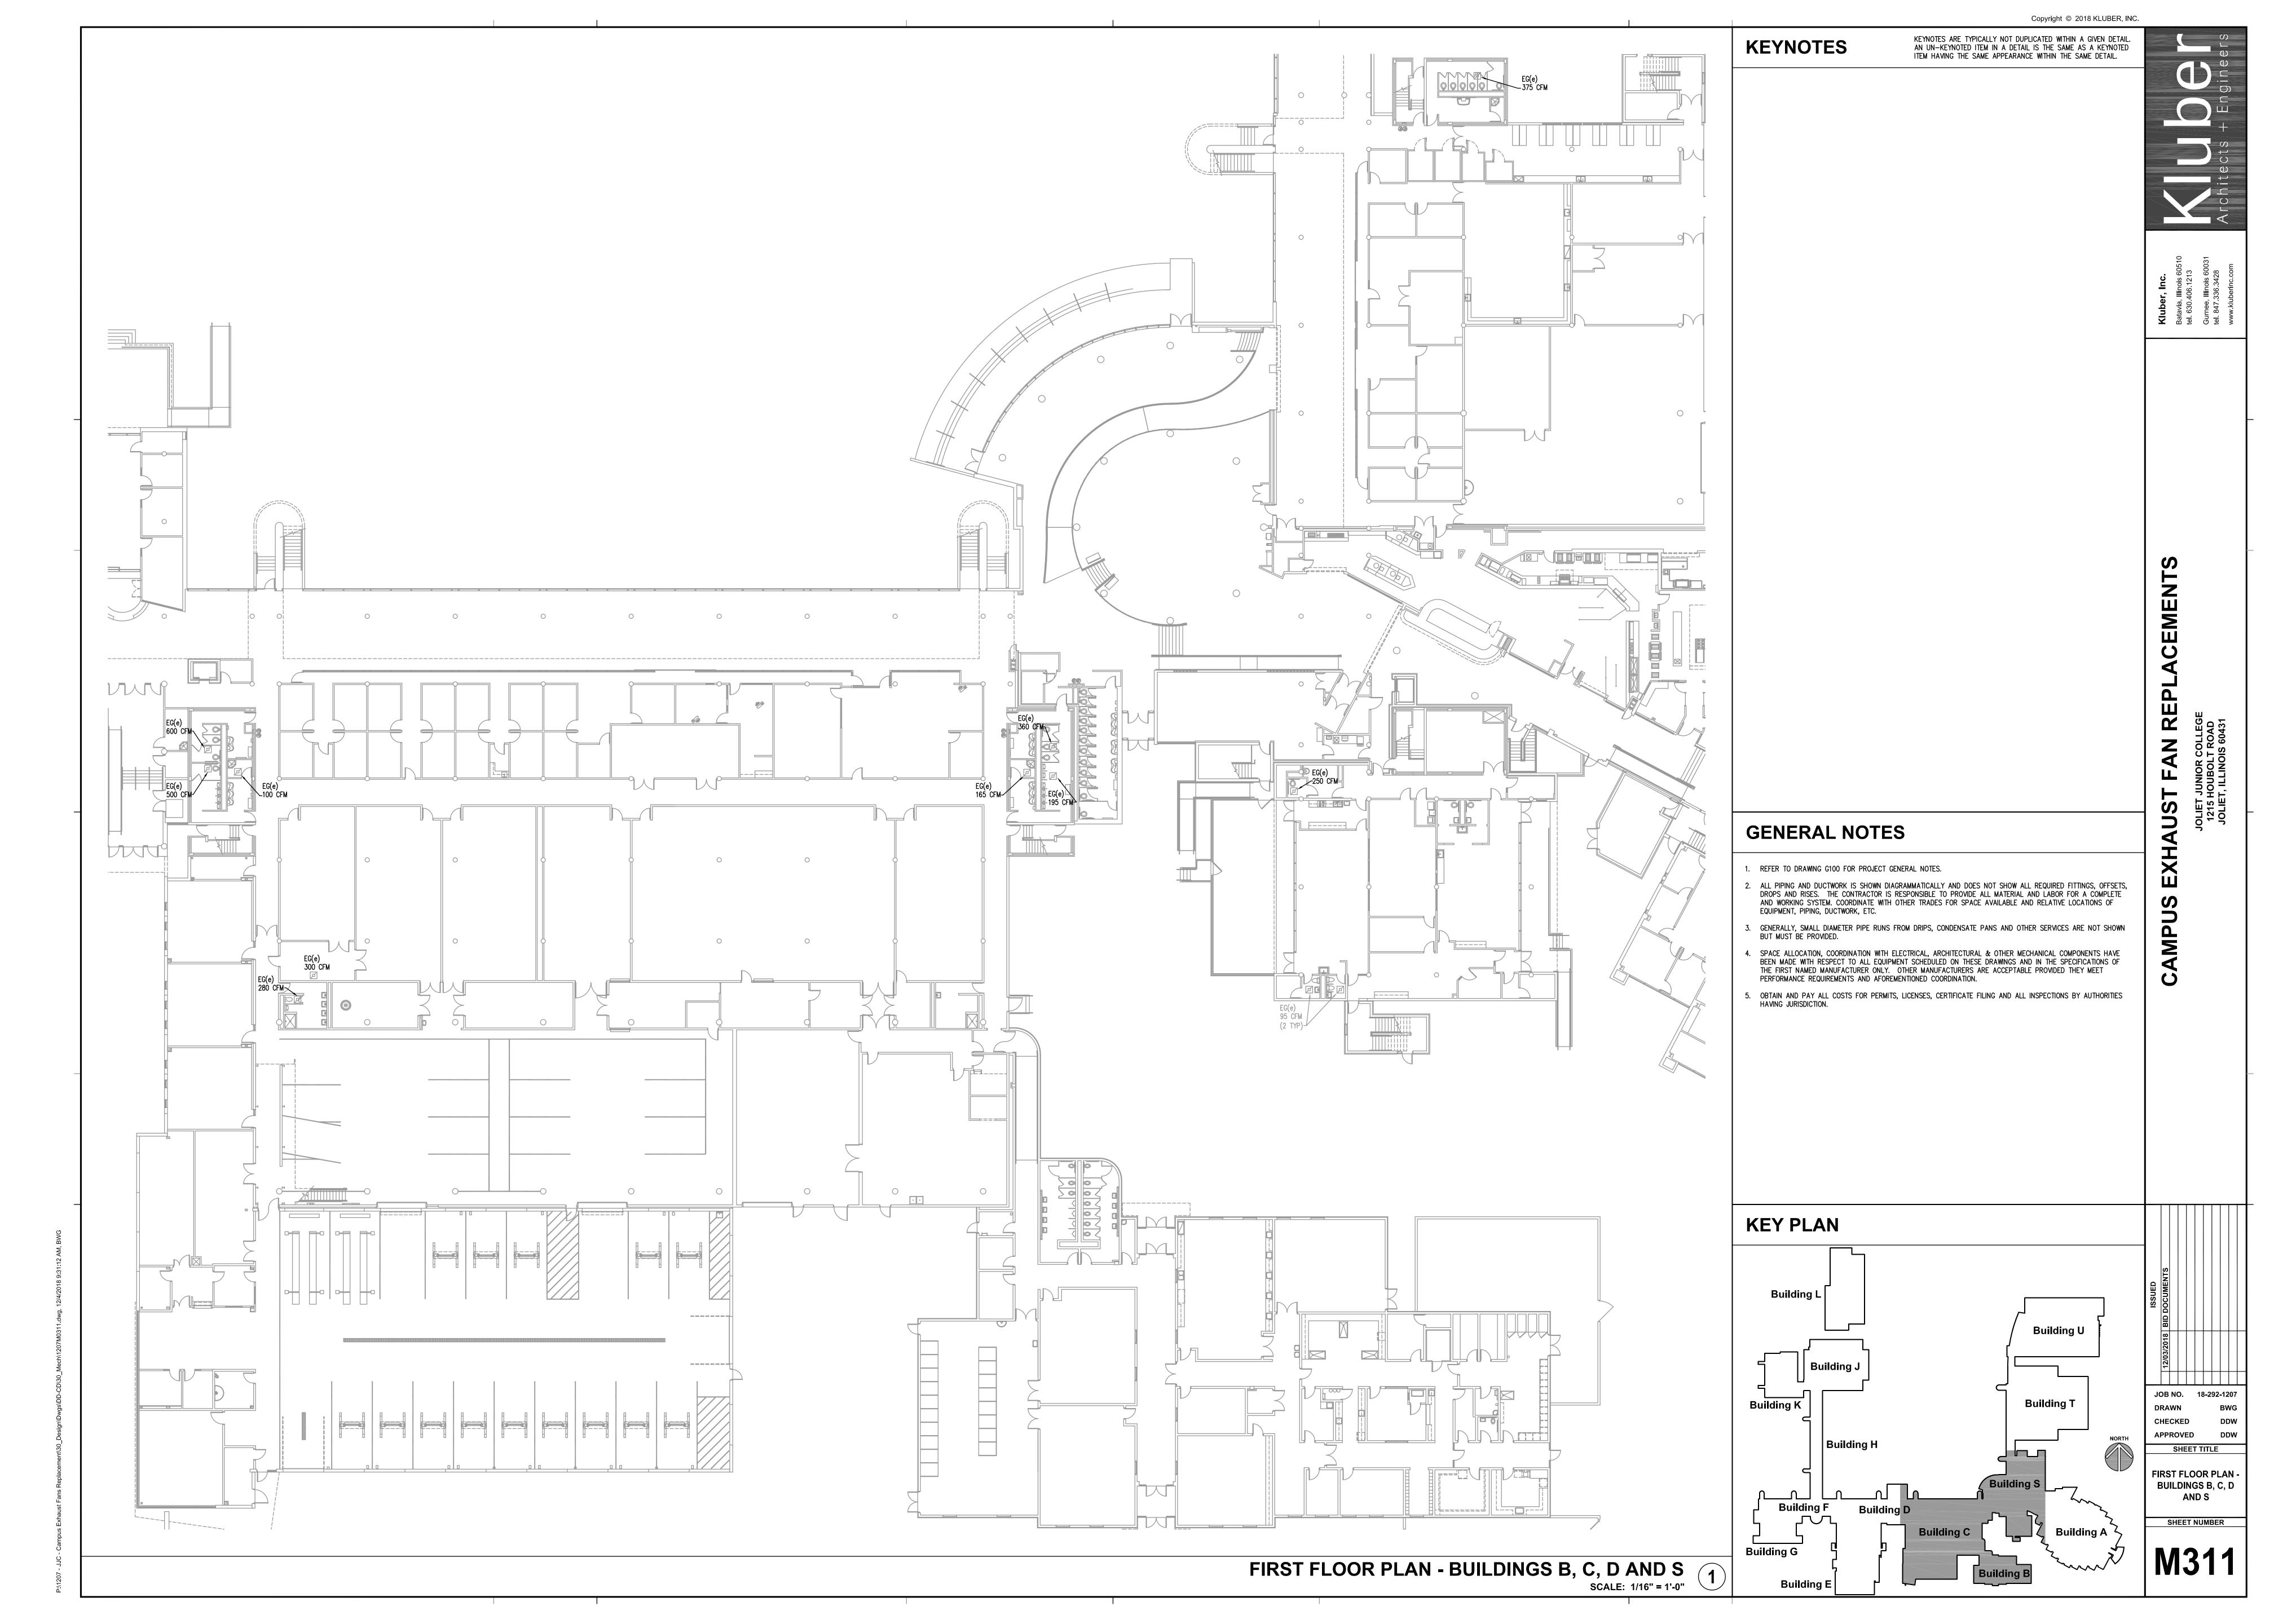

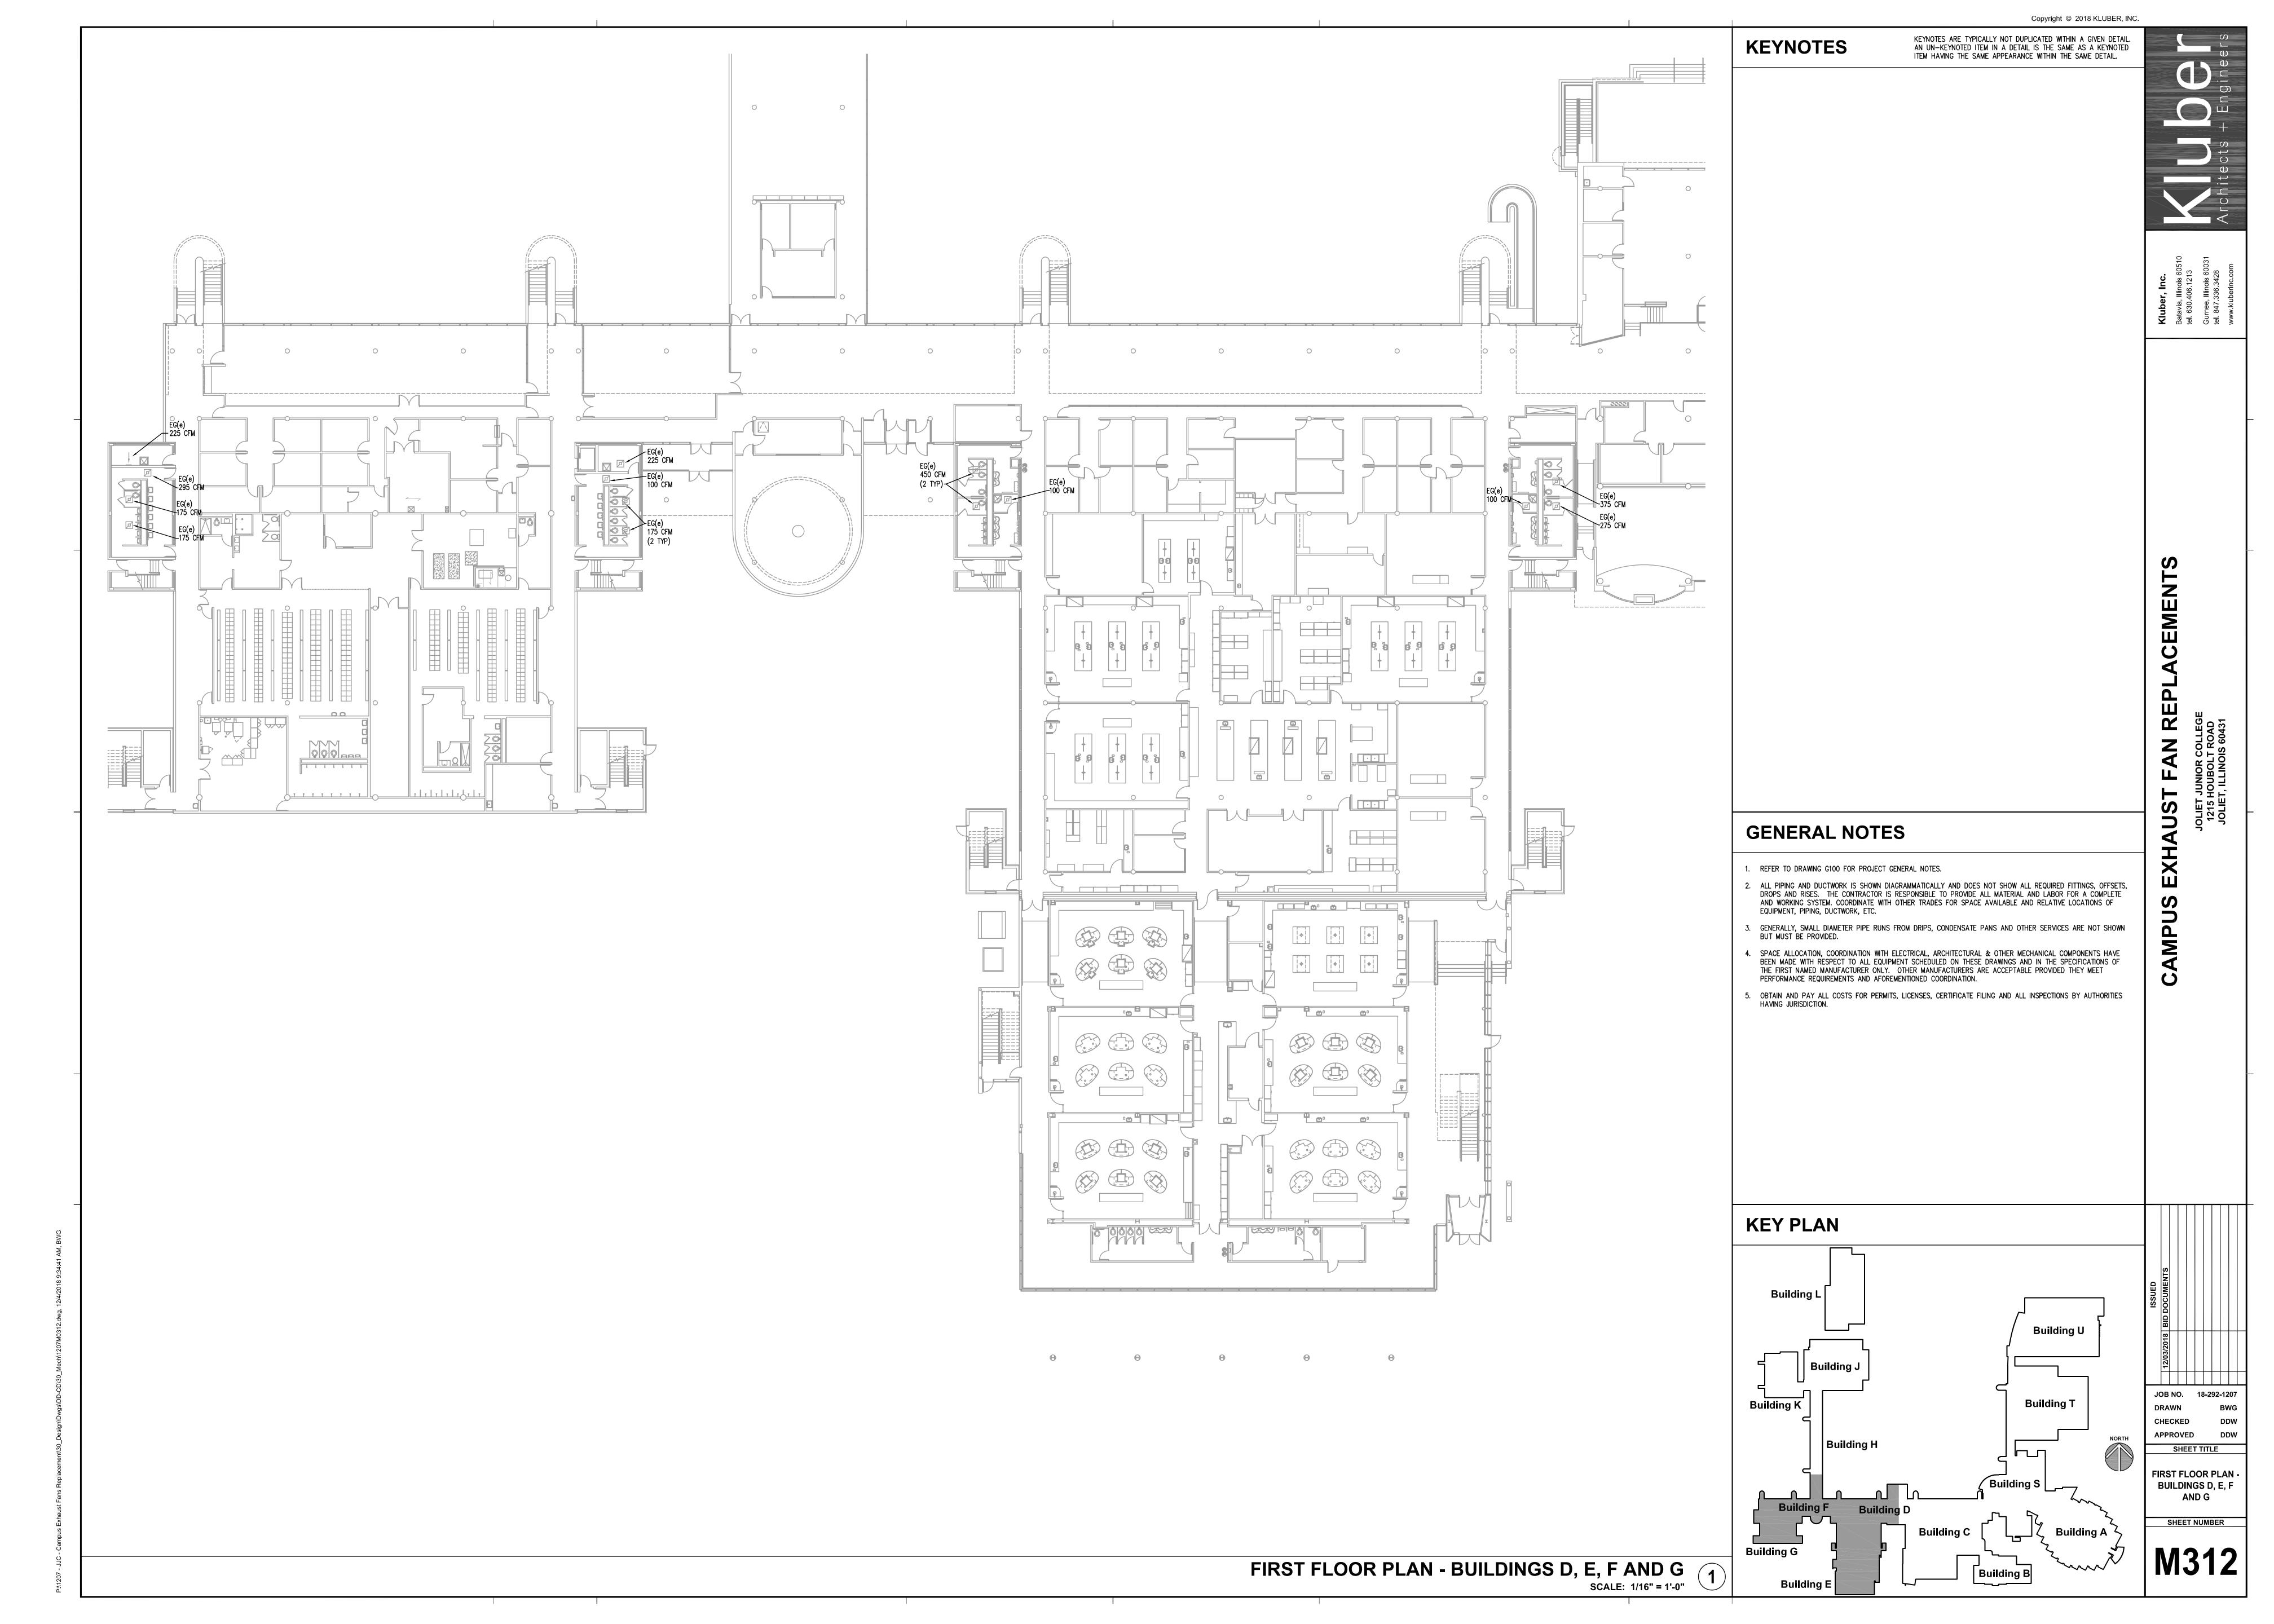

AND FITTINGS AS REQUIRED TO CONNECT NEW EXHAUST FANS TO EXISTING DUCTWORK. 26.201 DISCONNECT, PRESERVE, AND PROTECT EXISTING ELECTRICAL CONNECTION TO EXHAUST FAN TO BE REPLACED. RECONNECT EXISTING BRANCH CIRCUITRY AND EXTEND AS NECESSARY TO NEW EQUIPMENT TO ENSURE A

COMPLETE AND OPERATIONAL SYSTEM. EXTEND EXISTING BRANCH CIRCUITRY AND PROVIDE ELECTRICAL CONNECTION TO MOTORIZED DAMPERS IN ACCORDANCE WITH MANUFACTURER'S INSTRUCTIONS TO ENSURE A COMPLETE AND OPERATIONAL SYSTEM.

EXHAUST FAN SEQUENCE OF OPERATIONS

IEF-9: THE EXHAUST FAN SHALL BE ENERGIZED BY ROOM LIGHT SWITCH.

IEF-10: THE EXHAUST FAN SHALL BE ENERGIZED BY ROOM LIGHT SWITCH.

FIRST FLOOR PLAN - BUILDINGS H SCALE: 1/16" = 1'-0"

MARK	AIR FLOW RATE (CFM)	EXTERNAL S.P. (IN WG)	TYPE	MOTOR (HP)	ELECTRICAL (V/PH/HZ)	LOCATION	MODEL	NOTES
IEF-9	930	0.5	CENTRIFUGAL	1/3	115/1/60	RM 201	SQND-VF	1
IEF-10	930	0.5	CENTRIFUGAL	1/3	115/1/60	RM 201	SQND-VF	1

FAN SCHEDULE


1. MODEL BASED ON COOK.

1. REFER TO DRAWING G100 FOR PROJECT GENERAL NOTES.

- . ALL PIPING AND DUCTWORK IS SHOWN DIAGRAMMATICALLY AND DOES NOT SHOW ALL REQUIRED FITTINGS, OFFSETS, DROPS AND RISES. THE CONTRACTOR IS RESPONSIBLE TO PROVIDE ALL MATERIAL AND LABOR FOR A COMPLETE AND WORKING SYSTEM. COORDINATE WITH OTHER TRADES FOR SPACE AVAILABLE AND RELATIVE LOCATIONS OF EQUIPMENT, PIPING, DUCTWORK, ETC.

- 5. OBTAIN AND PAY ALL COSTS FOR PERMITS, LICENSES, CERTIFICATE FILING AND ALL INSPECTIONS BY AUTHORITIES HAVING JURISDICTION.

KEY PLAN

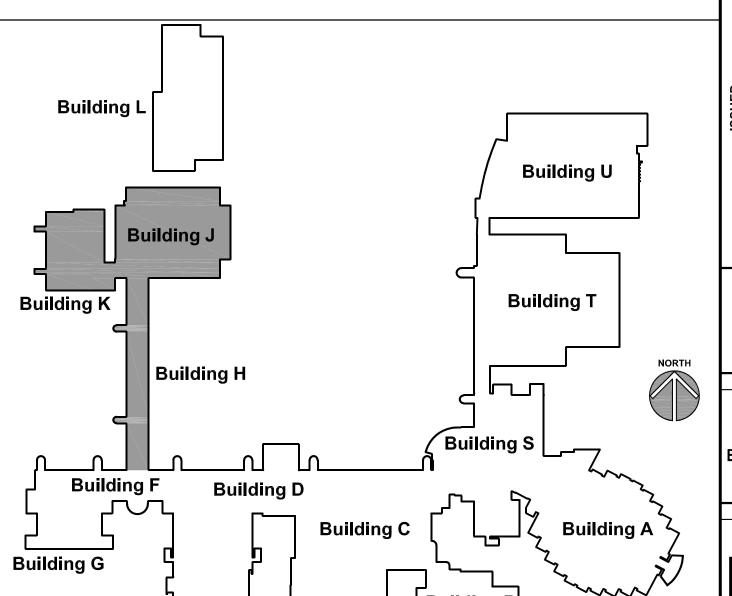

FIRST FLOOR PLAN -BUILDINGS H, J AND K

SHEET TITLE

SHEET NUMBER **ME313**

FIRST FLOOR PLAN - BUILDINGS H, J AND K
SCALE: 1/16" = 1'-0"


EG(e) 465 CFM (2 TYP) EG(e) ^J 465 CFM (2 TYP) EG(e) 225 CFM EG(e) 170 CFM


GENERAL NOTES

GENERALLY, SMALL DIAMETER PIPE RUNS FROM DRIPS, CONDENSATE PANS AND OTHER SERVICES ARE NOT SHOWN BUT MUST BE PROVIDED.

. SPACE ALLOCATION, COORDINATION WITH ELECTRICAL, ARCHITECTURAL & OTHER MECHANICAL COMPONENTS HAVE BEEN MADE WITH RESPECT TO ALL EQUIPMENT SCHEDULED ON THESE DRAWINGS AND IN THE SPECIFICATIONS OF THE FIRST NAMED MANUFACTURER ONLY. OTHER MANUFACTURERS ARE ACCEPTABLE PROVIDED THEY MEET PERFORMANCE REQUIREMENTS AND AFOREMENTIONED COORDINATION.

Building E

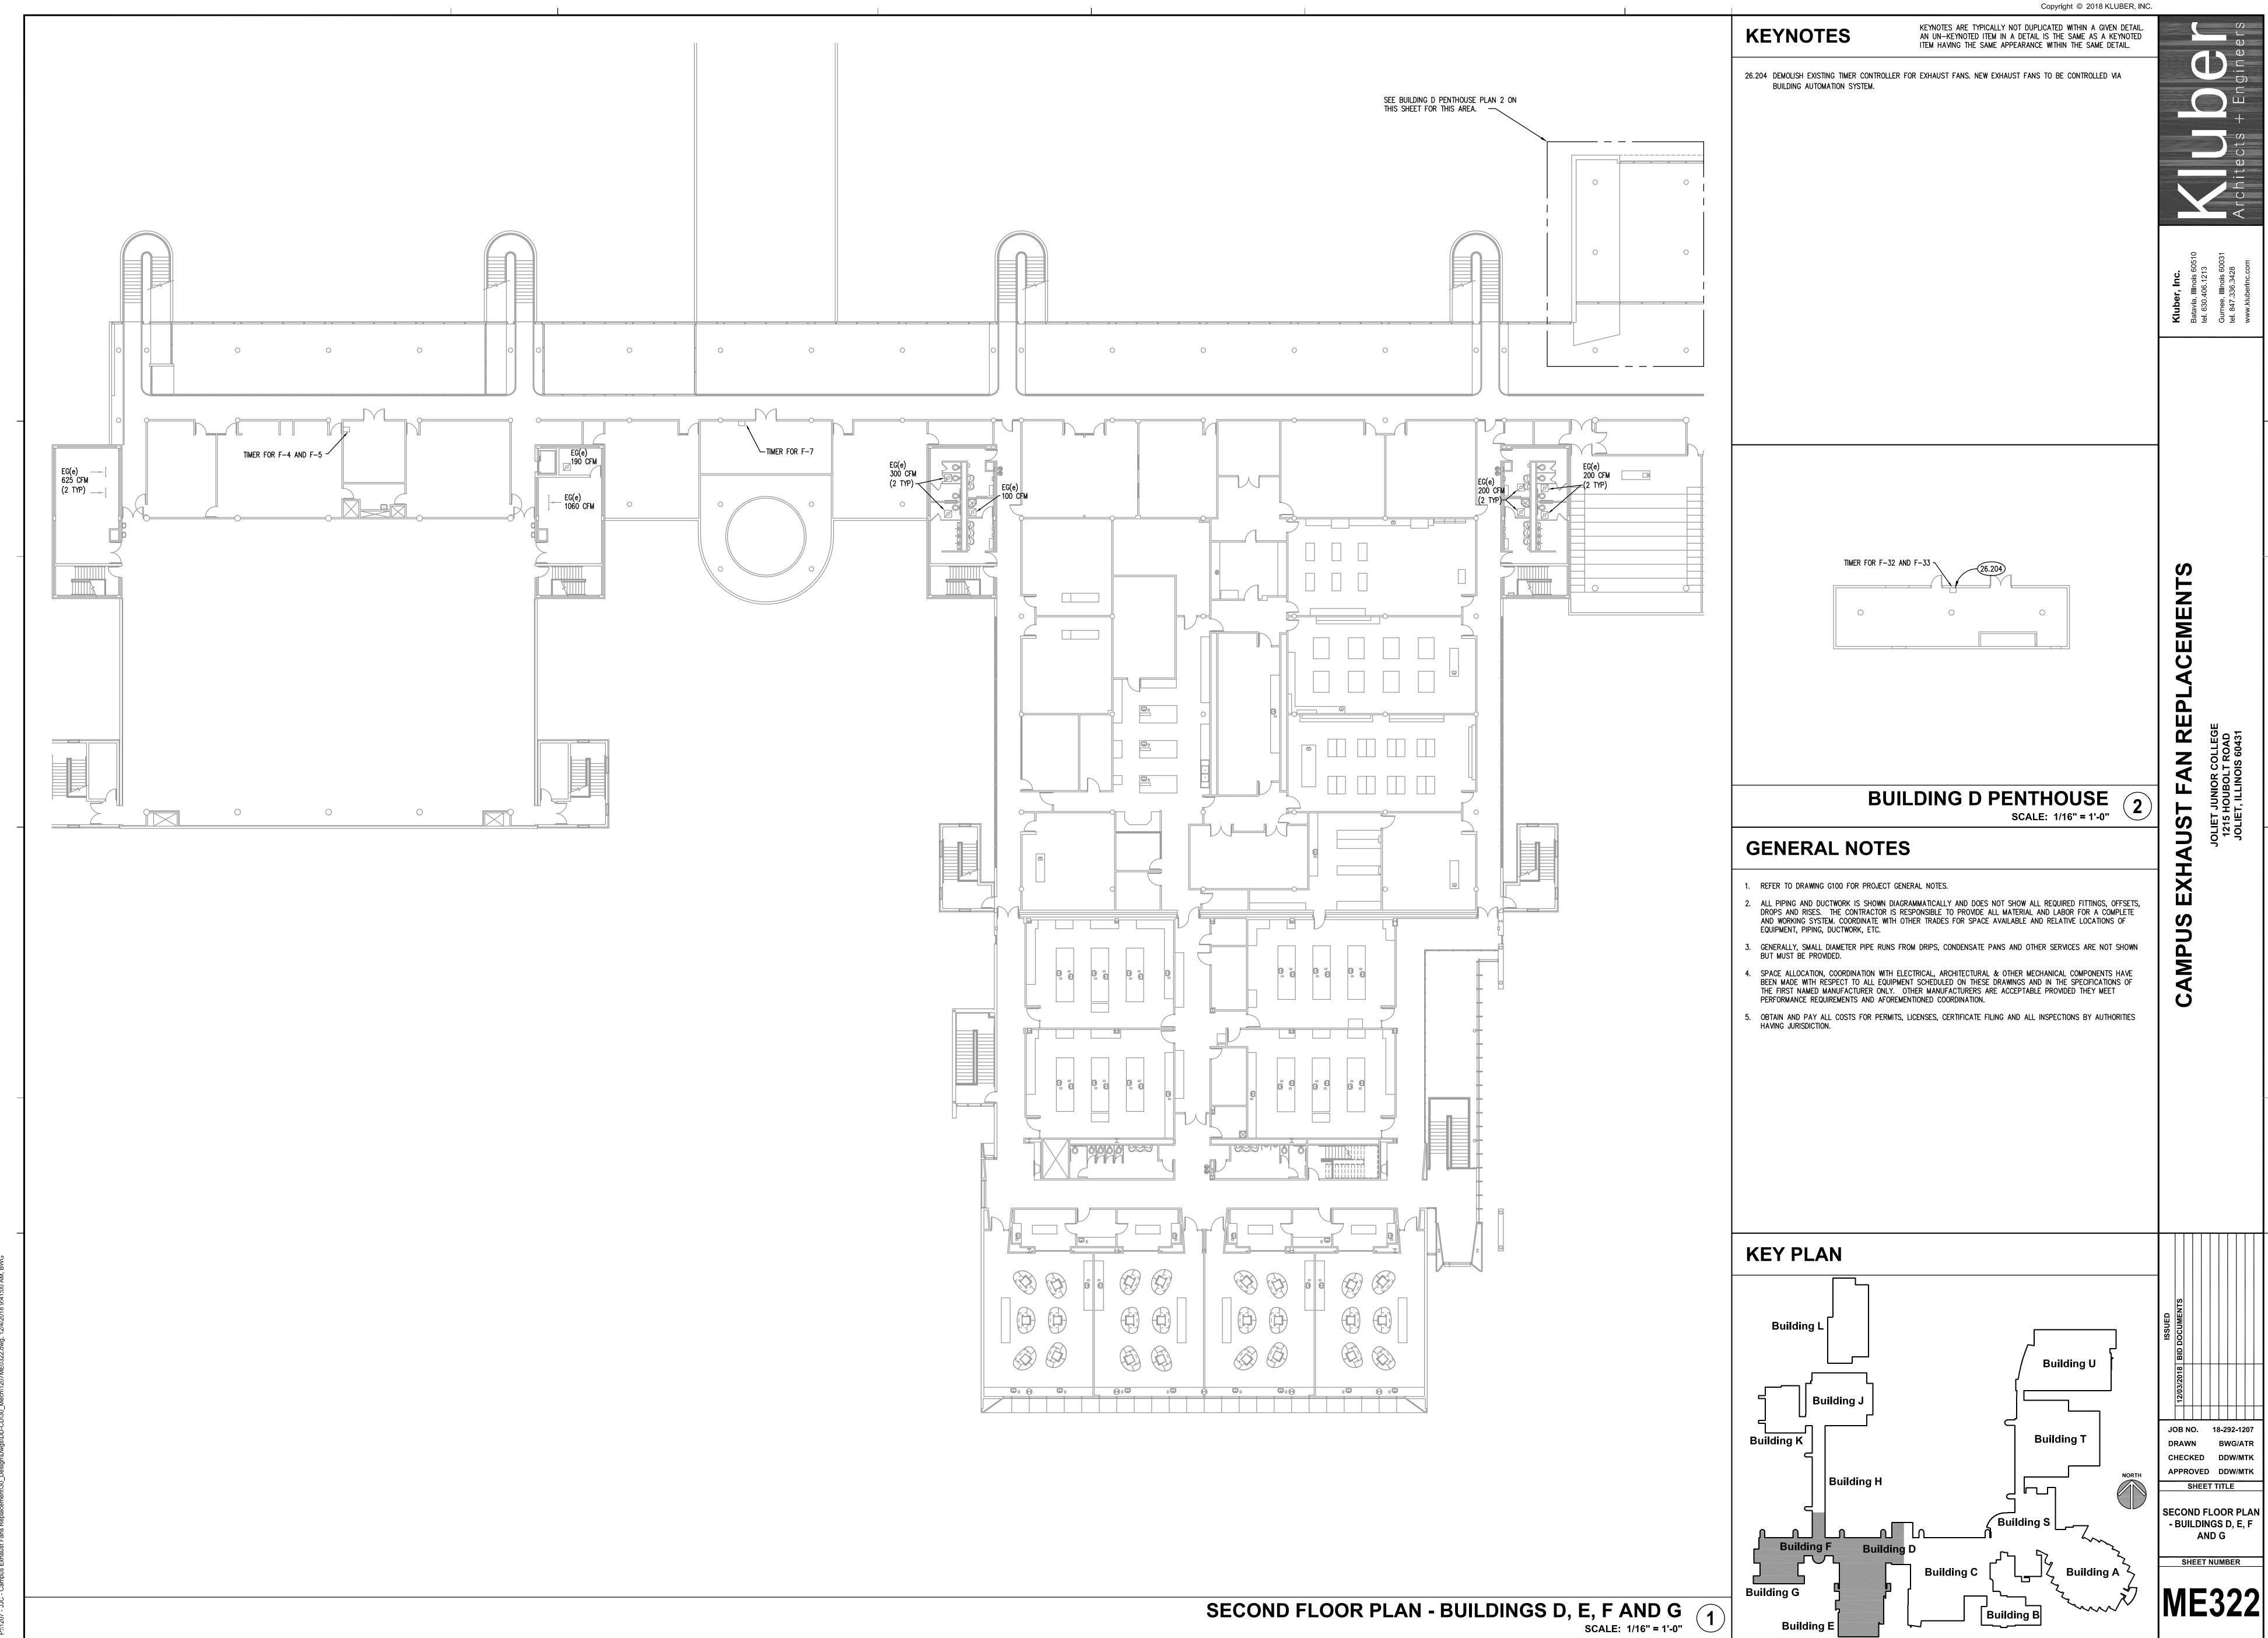


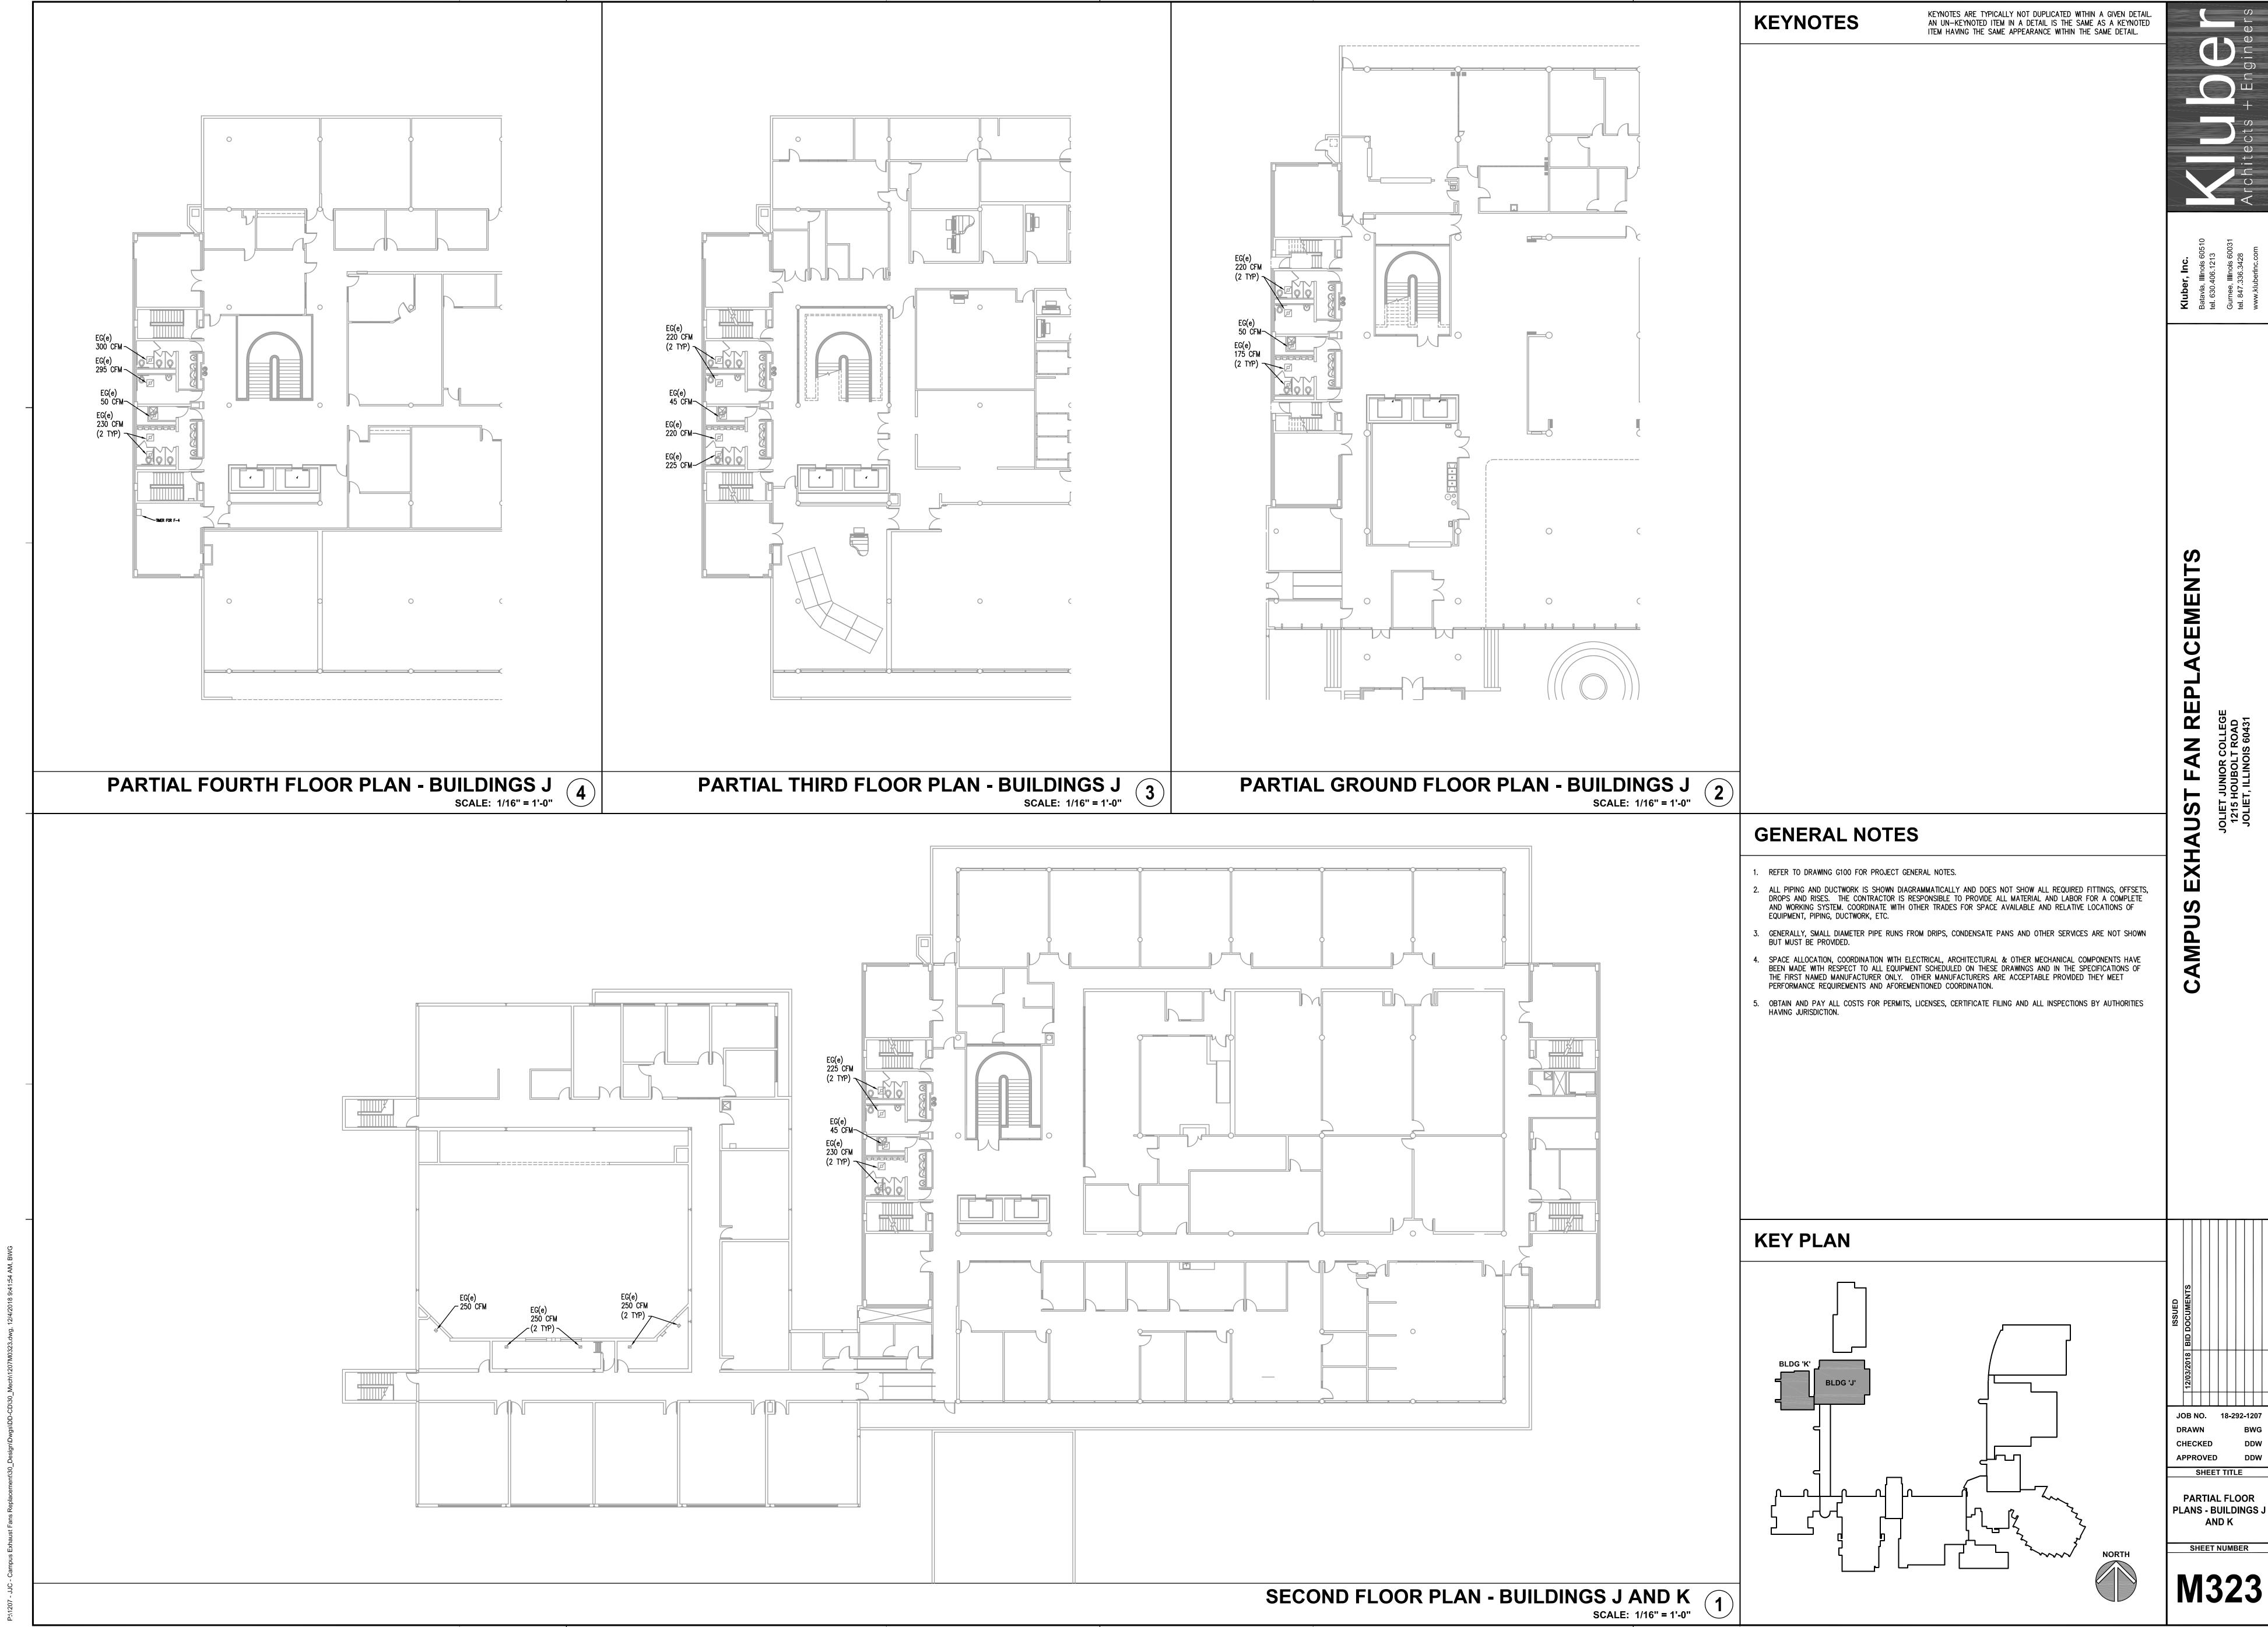

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SHEET TITLE

AND S

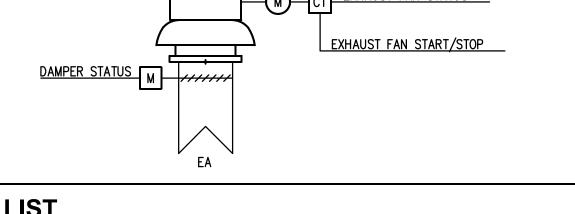

SEQUENCE OF OPERATIONS

- F-33: THE EXHAUST FAN SHALL BE ENERGIZED AS SCHEDULED IN THE BUILDING AUTOMATION SYSTEM.
- F-36: THE EXHAUST FAN SHALL BE ENERGIZED BY TIMER.
- F-43: THE EXHAUST FAN SHALL BE ENERGIZED BY TIMER.
- THE EXHAUST FAN SHALL BE ENERGIZED BY TIMER.
- THE EXHAUST FAN SHALL BE ENERGIZED AS SCHEDULED IN THE BUILDING AUTOMATION SYSTEM.
- F-53-54: THE EXHAUST FAN SHALL BE ENERGIZED BY HOOD SWITCH. A SCHEDULE SHALL BE CREATED IN THE BUILDING AUTOMATION SYSTEM TO DE-ENERGIZE THE FAN AT SCHEDULED TIMES.

FAN SCHEDULE


MARK	AIR FLOW RATE (CFM)	EXTERNAL S.P. (IN WG)	TYPE	MOTOR (HP)	ELECTRICAL (V/PH/HZ)	LOCATION	MODEL	NOTES	
F-33	2000	0.5	CENTRIFUGAL	1/3	115/1/60	D ROOF	ACED-VF	1, 2	
F-36	580	0.5	CENTRIFUGAL	1/4	115/1/60	C ROOF	ACED-EC	1, 2	
F-40	5250	3.0	CENTRIFUGAL	7.5	460/3/60	C ROOF	CMB-35	2, 3	
F-43	1500	0.5	CENTRIFUGAL	1/3	115/1/60	C ROOF	ACED-VF	1, 2	
F-46	190	0.25	CENTRIFUGAL	1/4	115/1/60	A ROOF	ACED-EC	1, 2	
F-47	535	0.375	CENTRIFUGAL	1/4	115/1/60	A ROOF	ACED-EC	1, 2	
F-52	825	0.5	CENTRIFUGAL	1/3	115/1/60	S ROOF	ACED-VF	1, 2	

FAN COLOR = WHITE.MODEL BASED ON CAR-MON.

- 1. REFER TO DRAWING G100 FOR PROJECT GENERAL NOTES.
- BUT MUST BE PROVIDED.
- PERFORMANCE REQUIREMENTS AND AFOREMENTIONED COORDINATION.
- 5. OBTAIN AND PAY ALL COSTS FOR PERMITS, LICENSES, CERTIFICATE FILING AND ALL INSPECTIONS BY AUTHORITIES HAVING JURISDICTION.

KEY PLAN

Building E

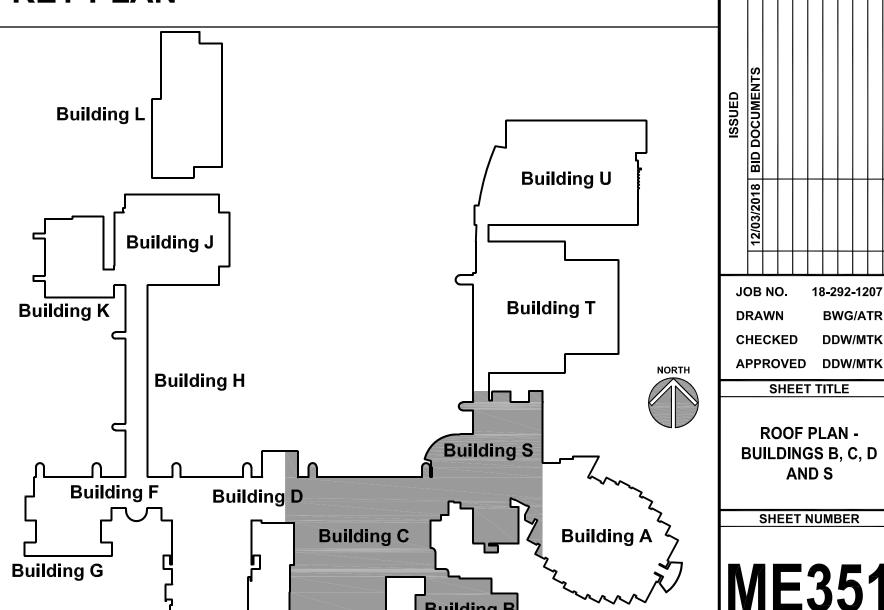

23.202 23.202 26.201 23.202 23.206 26.201 □ F-46(e)

ROOF PLAN - BUILDINGS B, C, D AND S
SCALE: 1/16" = 1'-0"

23.200 23.202 23.206 26.201

EXHAUST FAN CONTROL SCHEMATIC

23.201 APPROXIMATE DIMENSIONS OF EXISTING CURB IS 20" X 20". FIELD VERIFY EXACT DIMENSIONS PRIOR TO

23.202 APPROXIMATE DIMENSIONS OF EXISTING CURB IS 24" X 24". FIELD VERIFY EXACT DIMENSIONS PRIOR TO


23.210 PROVIDE NEW GOOSENECK DISCHARGE ON NEW EXHAUST FAN. GOOSENECK SHALL BE WHITE IN COLOR.

26.200 DEMOLISH EXISTING ELECTRICAL CONNECTION TO EXHAUST FAN TO BE REPLACED. REMOVE ALL ABANDONED

26.203 PROVIDE ELECTRICAL CONNECTION TO EF-40. HOMERUN 3#12,#12G,1/2"C TO SPARE 20 AMPERE, 3 POLE

RECONNECT EXISTING BRANCH CIRCUITRY AND EXTEND AS NECESSARY TO NEW EQUIPMENT TO ENSURE A COMPLETE AND OPERATIONAL SYSTEM. EXTEND EXISTING BRANCH CIRCUITRY AND PROVIDE ELECTRICAL CONNECTION TO MOTORIZED DAMPERS IN ACCORDANCE WITH MANUFACTURER'S INSTRUCTIONS TO ENSURE A

BREAKER IN PANEL GA-25/27/29. PANEL GA IS LOCATED IN MECHANICAL ROOM C2024. EXHAUST FAN TO BE CONTROLLED THROUGH EXISTING SWITCH LOCATED IN AUTO SHOP C1001. PROVIDE BRANCH CIRCUITRY THROUGH

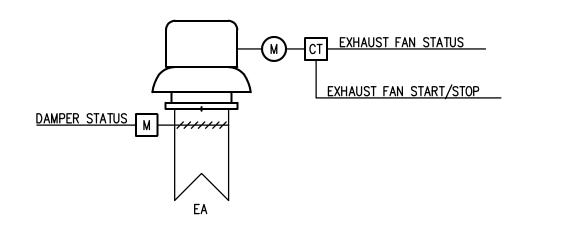

POINTS LIST

KEYNOTES

CONSTRUCTION.

BRANCH CIRCUITRY.

23.206 TIE NEW FAN INTO THE BUILDING AUTOMATION SYSTEM.

COMPLETE AND OPERATIONAL SYSTEM.

23.208 TIE EXISTING EXHAUST FAN INTO BUILDING AUTOMATION SYSTEM.

NEW EXHAUST FAN. MOUNT NEW EXHAUST FAN ON EXISTING ROOF RAILS.

EXISTING SWITCH TO ENSURE A COMPLETE AND OPERATIONAL SYSTEM.


	EXHAUST FAN		HARD	WARE		SOFTWARE			
		Al	AO	DI	DO	SCHED	TREND	ALARM	GRAPHI(
	FAN START/STOP				Х	Χ			Χ
·	FAN STATUS			Χ			Χ	Χ	Χ
·	DAMPER STATUS			Χ				Χ	Χ
·	SWITCH STATUS			Х			Х		Χ

- F-40: THE EXHAUST FAN SHALL BE ENERGIZED BY ROOM SWITCH.

MODEL BASED ON COOK.

GENERAL NOTES

- 2. ALL PIPING AND DUCTWORK IS SHOWN DIAGRAMMATICALLY AND DOES NOT SHOW ALL REQUIRED FITTINGS, OFFSETS, DROPS AND RISES. THE CONTRACTOR IS RESPONSIBLE TO PROVIDE ALL MATERIAL AND LABOR FOR A COMPLETE AND WORKING SYSTEM. COORDINATE WITH OTHER TRADES FOR SPACE AVAILABLE AND RELATIVE LOCATIONS OF EQUIPMENT, PIPING, DUCTWORK, ETC.
- 3. GENERALLY, SMALL DIAMETER PIPE RUNS FROM DRIPS, CONDENSATE PANS AND OTHER SERVICES ARE NOT SHOWN
- 4. SPACE ALLOCATION, COORDINATION WITH ELECTRICAL, ARCHITECTURAL & OTHER MECHANICAL COMPONENTS HAVE BEEN MADE WITH RESPECT TO ALL EQUIPMENT SCHEDULED ON THESE DRAWINGS AND IN THE SPECIFICATIONS OF THE FIRST NAMED MANUFACTURER ONLY. OTHER MANUFACTURERS ARE ACCEPTABLE PROVIDED THEY MEET

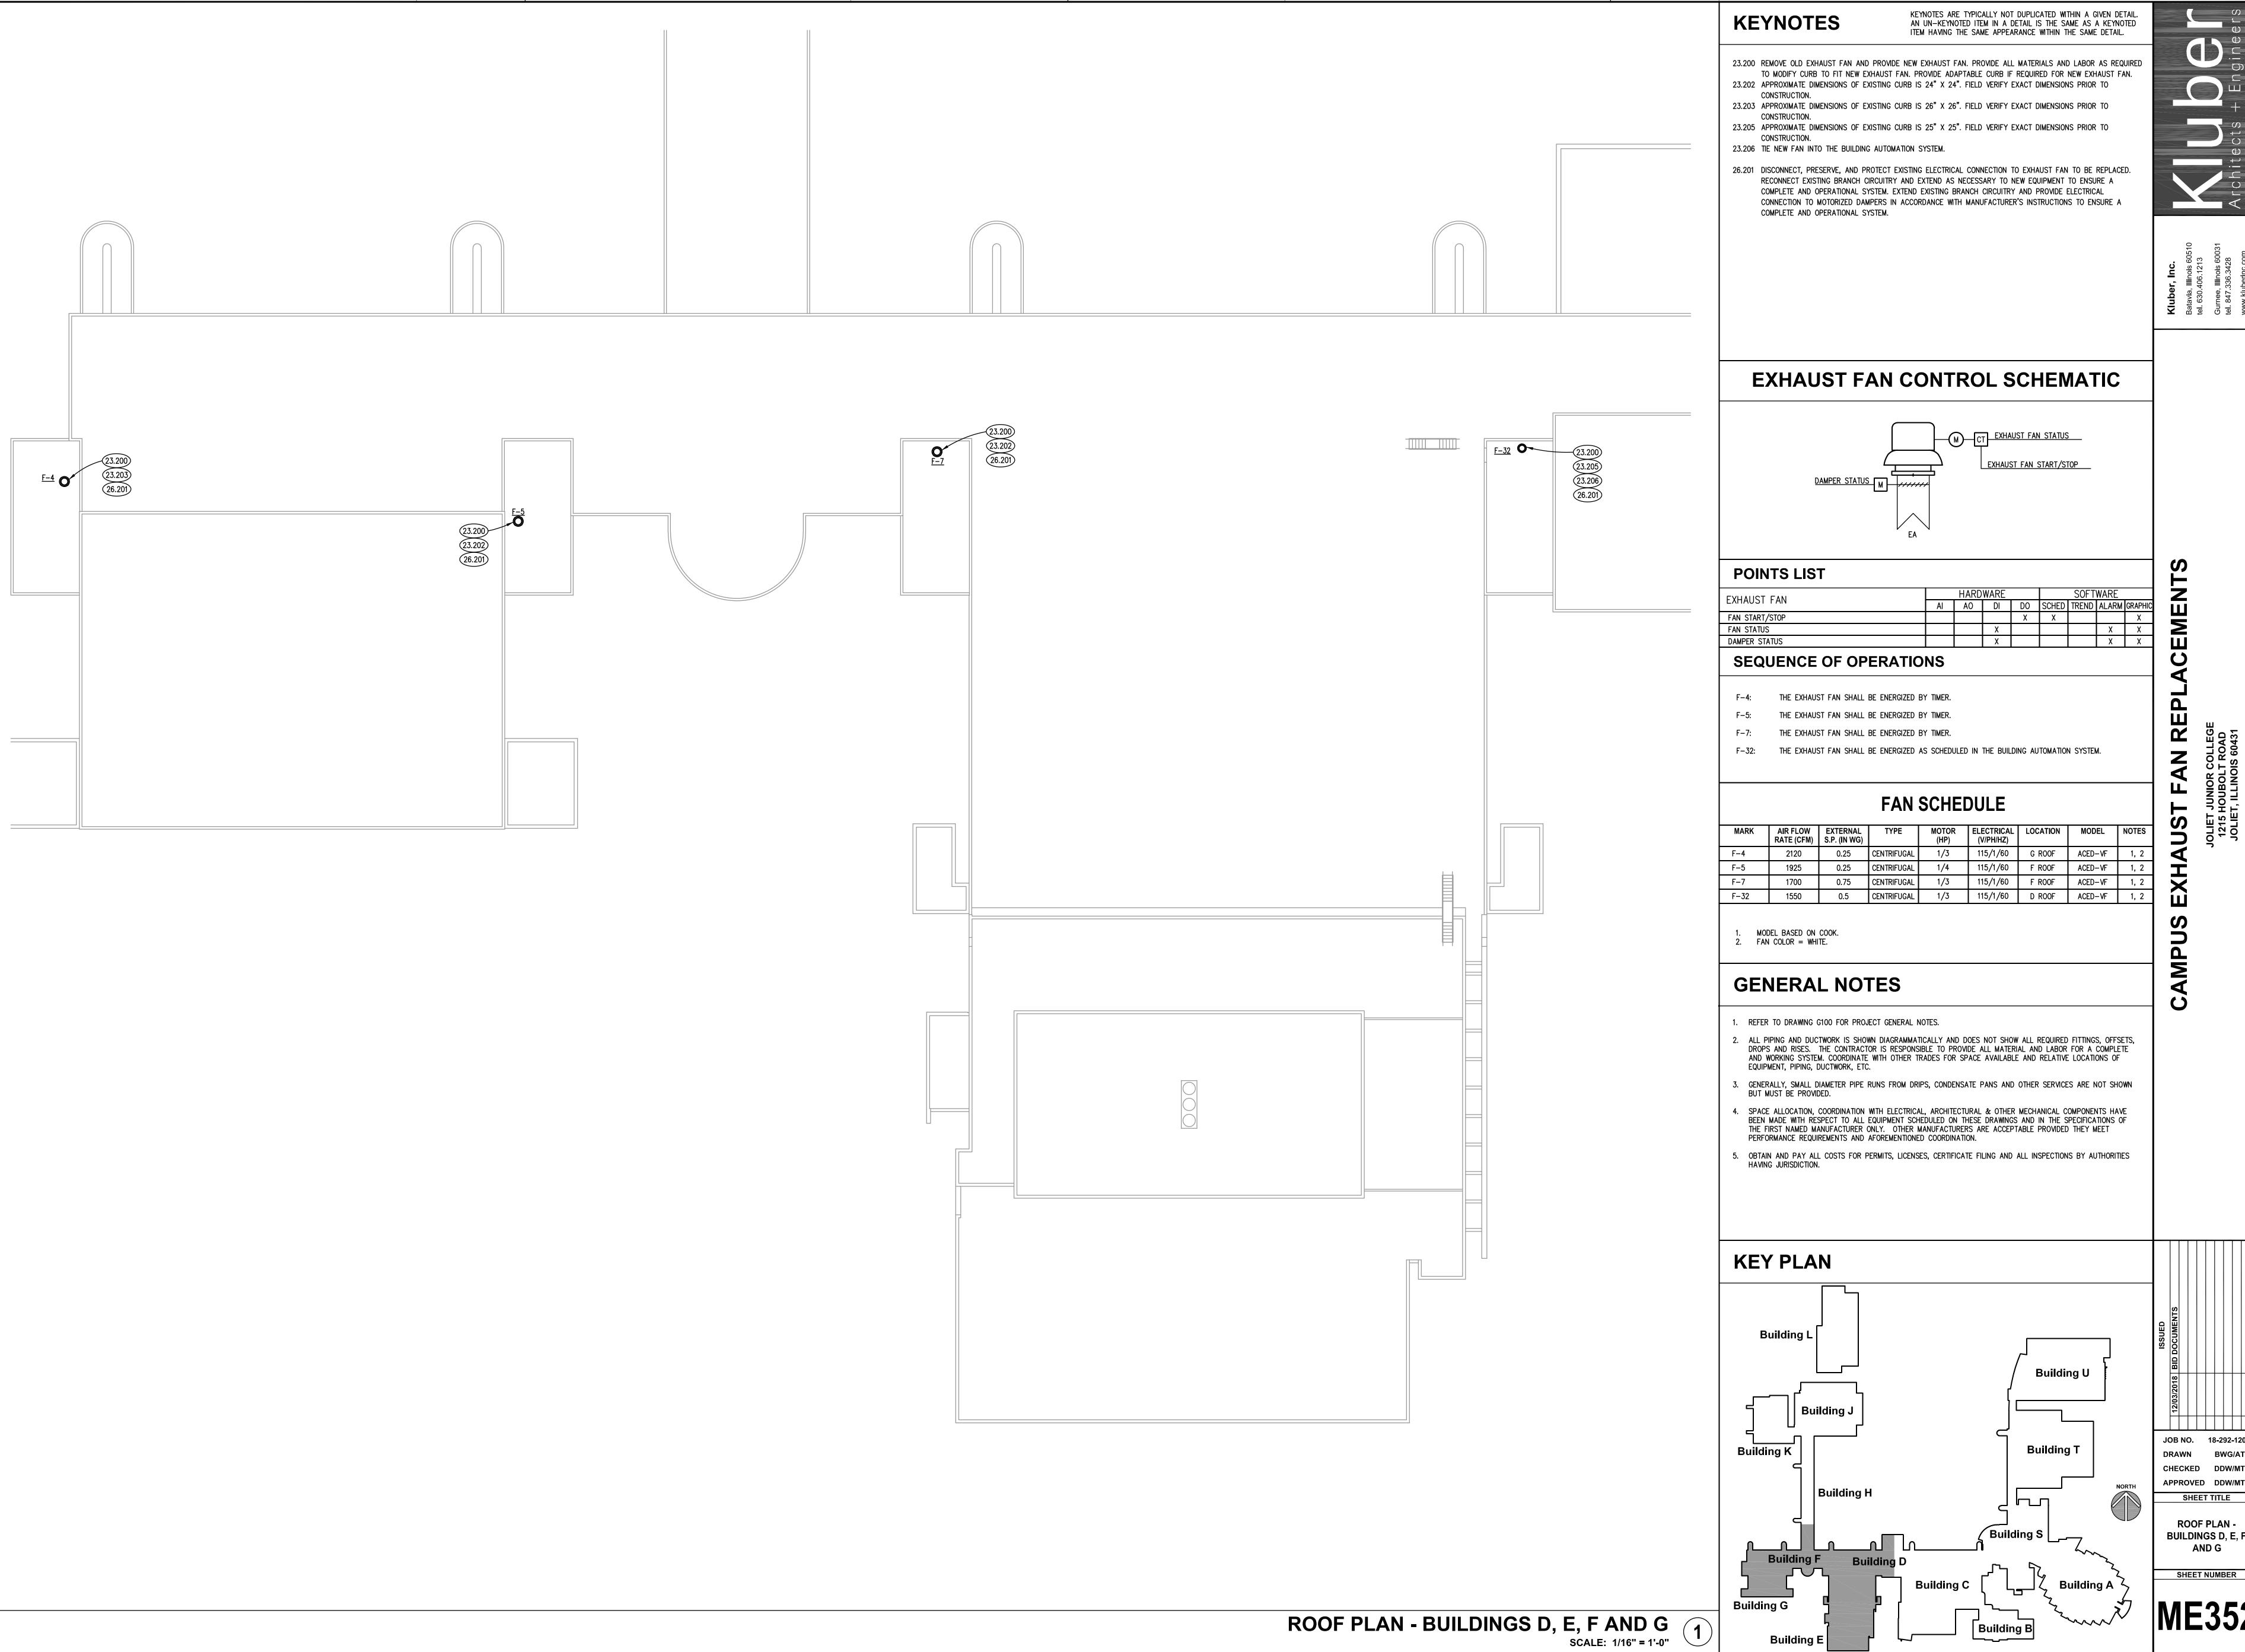

SHEET TITLE **ROOF PLAN -**BUILDINGS D, E, F